
1 ADDENDUM #1

ALL CLAUSES SET FORTH IN THE BIDDING DOCUMENTS, CONTRACT DOCUMENTS AND GENERAL REQUIREMENTS OF THE ORIGINAL CONTRACT DOCUMENTS SHALL APPLY TO AND GOVERN THIS WORK. THE ADDENDUM REFERS TO CHANGES AND ADDITIONS TO THE ORIGINAL CONTRACT DOCUMENTS AND IS TO BE READ IN CONJUNCTION WITH THE SAME. ALL OTHER PARTS OF THE ORIGINAL CONTRACT DOCUMENTS ARE TO BE CONSIDERED AS APPLYING TO THE WORK OF THIS CONTRACT WITH THE EXCEPTIONS AND CHANGES AS NOTED BELOW.

1.1 DRAWINGS

- .1 Reference Drawing C1 Site Plan & Details:
 - Delete this drawing in its entirety from the Drawing set and replace with Drawing C1 (Revision 1) Site Plan & Details, attached and forming part of this addendum.
 - .2 Note: Drawing C1 has been replaced to capture the addition of a ditch/swale along West border of parking lot.
- .2 Reference Drawing S1 Main Floor Slab Plan, Roof Plan, Sections & Notes:
 - .1 Delete this drawing in its entirety from the Drawing set and replace with Drawing S1 (Revision 1) Foundation & Roof Plan, Sections & Notes, attached and forming part of this addendum.
 - .2 <u>Note:</u> Drawing S1 has been replaced to capture the deletion of concrete thickened slab, provide concrete frost wall complete with gravel floor finish in warehouse, and additional headers at window openings.
- .3 Reference Drawing A1 Main Floor Plan, Roof Plan, Building Section & Notes:
 - .1 Delete this drawing in its entirety from the Drawing set and replace with Drawing A1 (Revision 1) Main Floor Plan, Roof Plan, Building Section & Notes, attached and forming part of this addendum.
 - .2 <u>Note:</u> Drawing A1 has been replaced to capture the deletion of concrete thickened slab, provide concrete frost wall complete with gravel floor finish in warehouse, addition of window glazing and door hardware clarifications.
- .4 Reference Drawing A2 Building Elevations:
 - Delete this drawing in its entirety from the Drawing set and replace with Drawing A2 (Revision 1) Building Elevations, attached and forming part of this addendum.
 - .2 <u>Note:</u> Drawing A2 has been replaced to capture the addition of (4) new window glazing units as indicated in drawings.

END OF SECTION

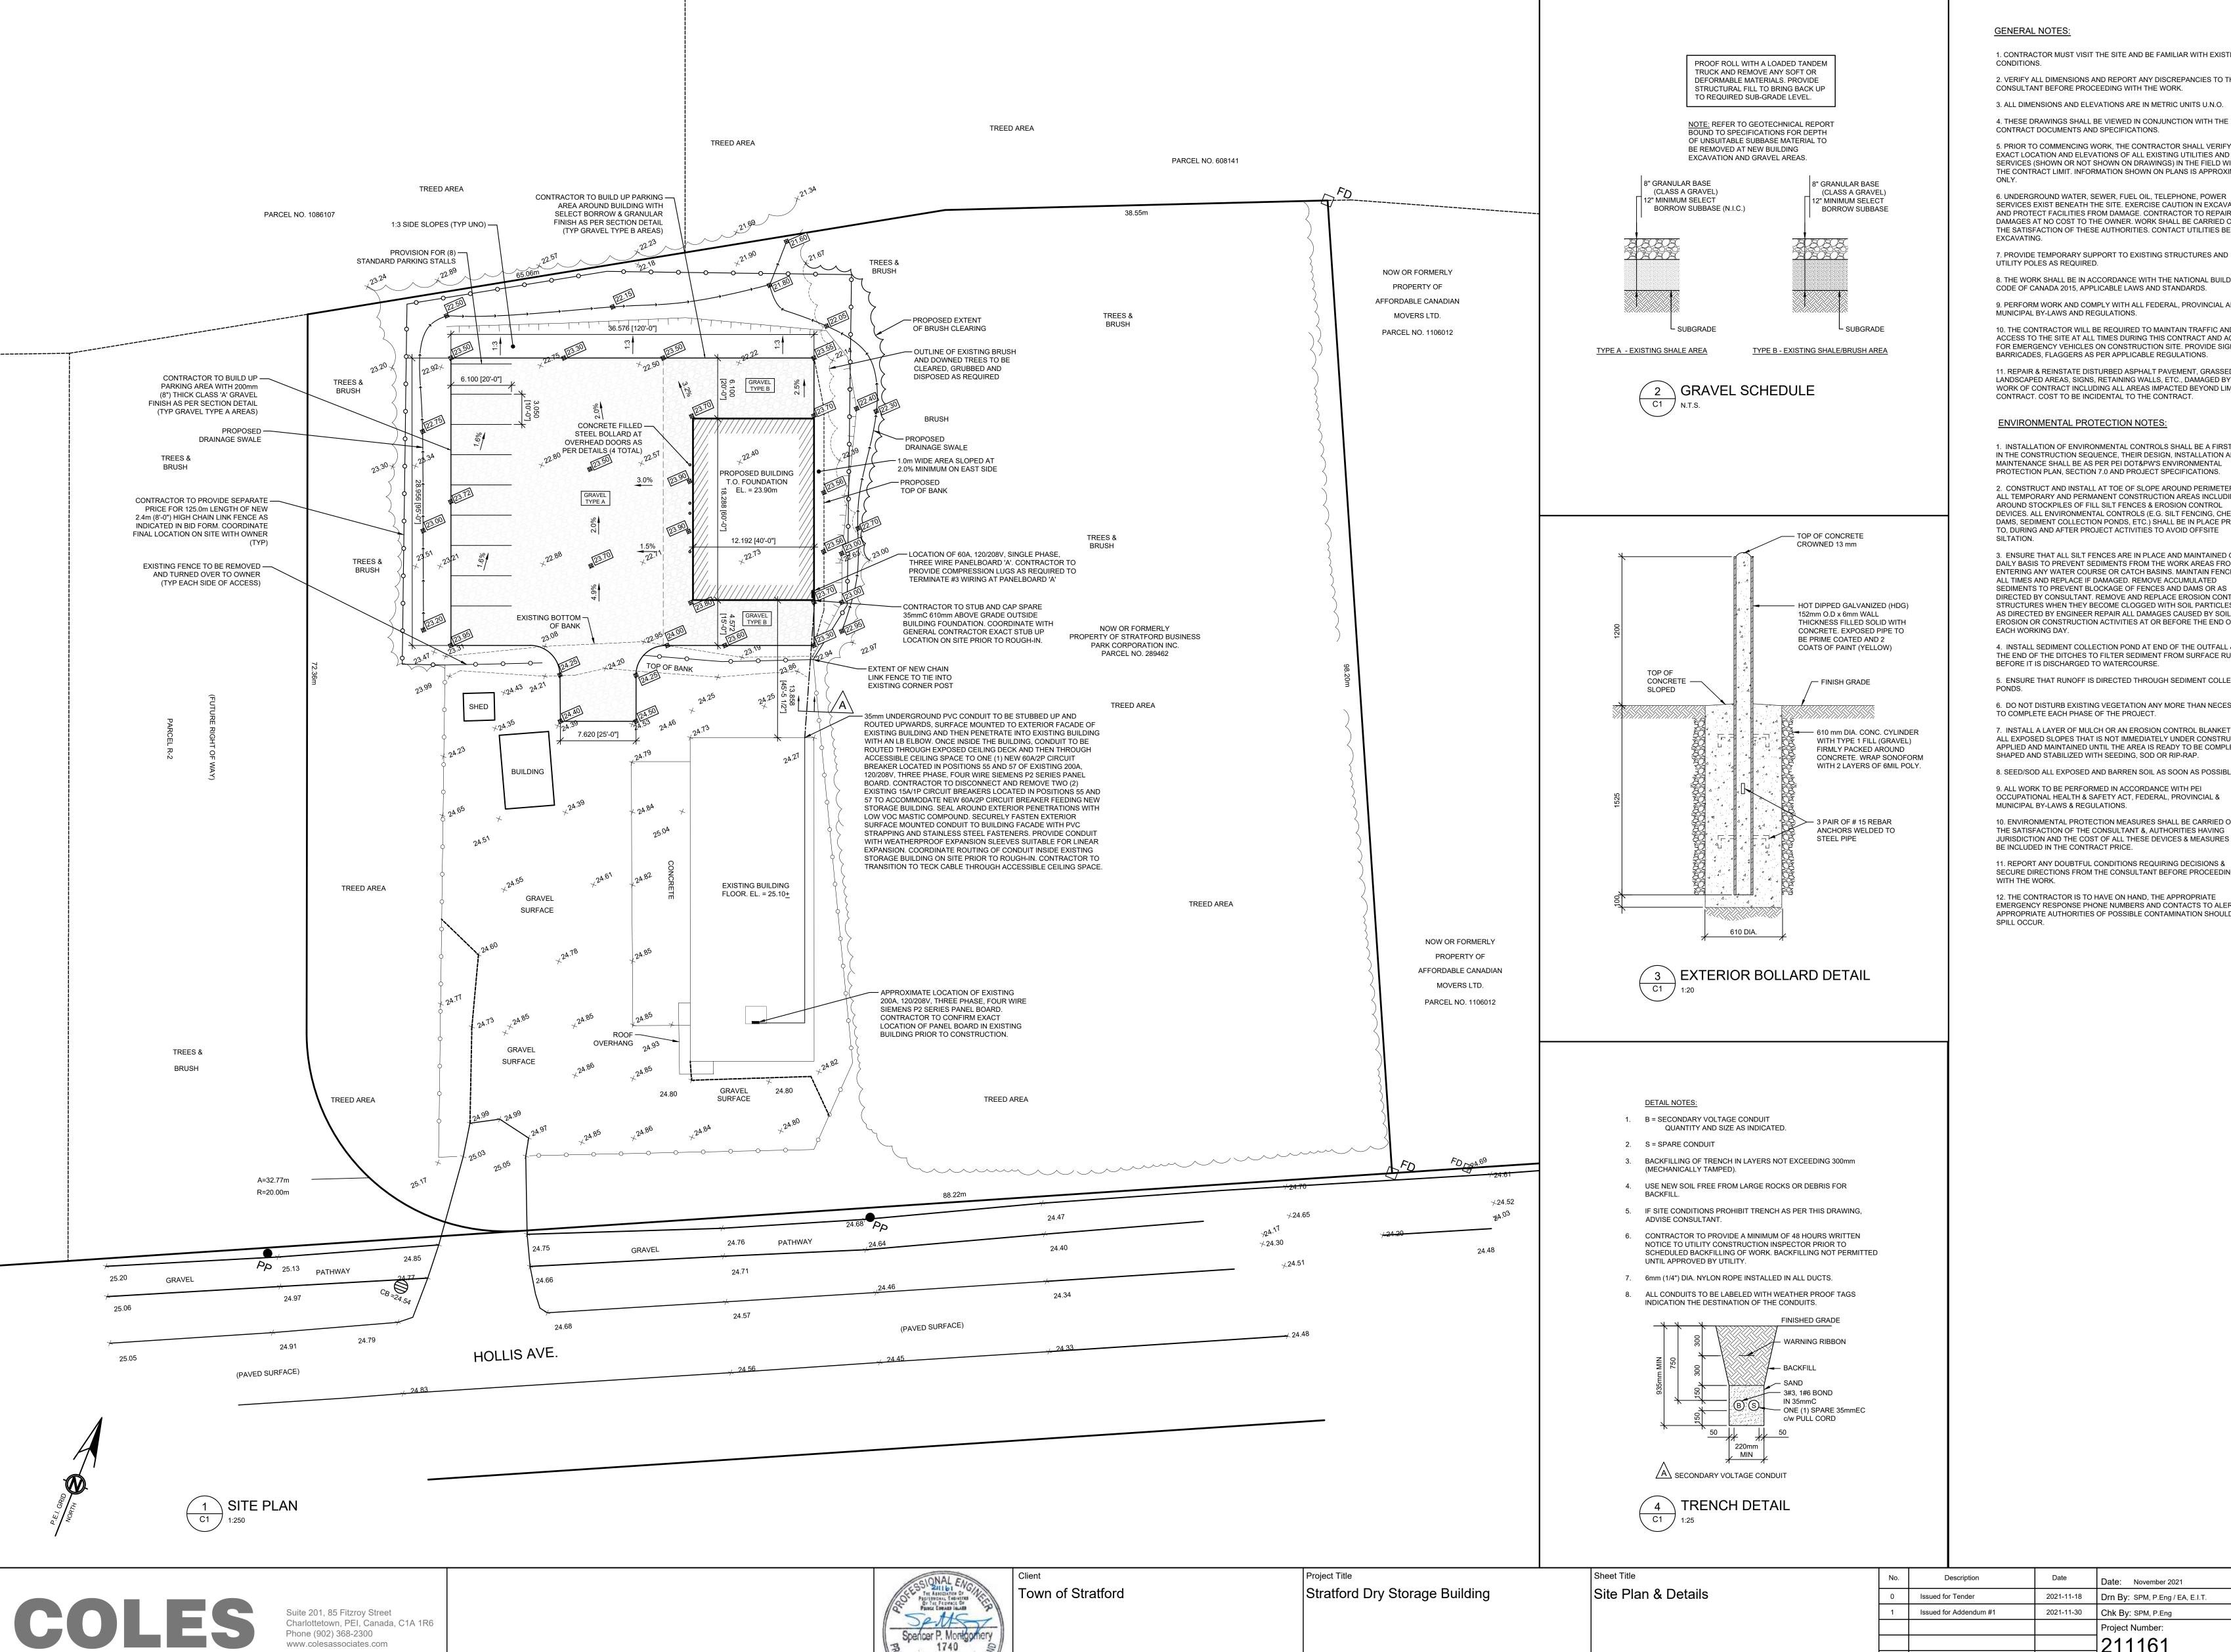

GENERAL NOTES:

1. CONTRACTOR MUST VISIT THE SITE AND BE FAMILIAR WITH EXISTING

2. VERIFY ALL DIMENSIONS AND REPORT ANY DISCREPANCIES TO THE

CONSULTANT BEFORE PROCEEDING WITH THE WORK.

3. ALL DIMENSIONS AND ELEVATIONS ARE IN METRIC UNITS U.N.O.

5. PRIOR TO COMMENCING WORK, THE CONTRACTOR SHALL VERIFY THE EXACT LOCATION AND ELEVATIONS OF ALL EXISTING UTILITIES AND SERVICES (SHOWN OR NOT SHOWN ON DRAWINGS) IN THE FIELD WITHIN THE CONTRACT LIMIT. INFORMATION SHOWN ON PLANS IS APPROXIMATE

6. UNDERGROUND WATER, SEWER, FUEL OIL, TELEPHONE, POWER SERVICES EXIST BENEATH THE SITE. EXERCISE CAUTION IN EXCAVATION AND PROTECT FACILITIES FROM DAMAGE. CONTRACTOR TO REPAIR DAMAGES AT NO COST TO THE OWNER. WORK SHALL BE CARRIED OUT TO THE SATISFACTION OF THESE AUTHORITIES. CONTACT UTILITIES BEFORE

7. PROVIDE TEMPORARY SUPPORT TO EXISTING STRUCTURES AND UTILITY POLES AS REQUIRED.

8. THE WORK SHALL BE IN ACCORDANCE WITH THE NATIONAL BUILDING CODE OF CANADA 2015, APPLICABLE LAWS AND STANDARDS.

9. PERFORM WORK AND COMPLY WITH ALL FEDERAL, PROVINCIAL AND MUNICIPAL BY-LAWS AND REGULATIONS.

10. THE CONTRACTOR WILL BE REQUIRED TO MAINTAIN TRAFFIC AND ACCESS TO THE SITE AT ALL TIMES DURING THIS CONTRACT AND ACCESS

FOR EMERGENCY VEHICLES ON CONSTRUCTION SITE. PROVIDE SIGNS, BARRICADES, FLAGGERS AS PER APPLICABLE REGULATIONS.

11. REPAIR & REINSTATE DISTURBED ASPHALT PAVEMENT, GRASSED & LANDSCAPED AREAS SIGNS RETAINING WALLS FTC. DAMAGED BY WORK OF CONTRACT INCLUDING ALL AREAS IMPACTED BEYOND LIMIT OF CONTRACT. COST TO BE INCIDENTAL TO THE CONTRACT.

ENVIRONMENTAL PROTECTION NOTES:

1. INSTALLATION OF ENVIRONMENTAL CONTROLS SHALL BE A FIRST STEP IN THE CONSTRUCTION SEQUENCE, THEIR DESIGN, INSTALLATION AND MAINTENANCE SHALL BE AS PER PEI DOT&PW'S ENVIRONMENTAL

2. CONSTRUCT AND INSTALL AT TOE OF SLOPE AROUND PERIMETER OF ALL TEMPORARY AND PERMANENT CONSTRUCTION AREAS INCLUDING AROUND STOCKPILES OF FILL SILT FENCES & EROSION CONTROL DEVICES, ALL ENVIRONMENTAL CONTROLS (E.G. SILT FENCING, CHECK DAMS, SEDIMENT COLLECTION PONDS, ETC.) SHALL BE IN PLACE PRIOR TO, DURING AND AFTER PROJECT ACTIVITIES TO AVOID OFFSITE

3. ENSURE THAT ALL SILT FENCES ARE IN PLACE AND MAINTAINED ON A DAILY BASIS TO PREVENT SEDIMENTS FROM THE WORK AREAS FROM ENTERING ANY WATER COURSE OR CATCH BASINS. MAINTAIN FENCE AT ALL TIMES AND REPLACE IF DAMAGED. REMOVE ACCUMULATED SEDIMENTS TO PREVENT BLOCKAGE OF FENCES AND DAMS OR AS DIRECTED BY CONSULTANT. REMOVE AND REPLACE EROSION CONTROL STRUCTURES WHEN THEY BECOME CLOGGED WITH SOIL PARTICLES OR AS DIRECTED BY ENGINEER REPAIR ALL DAMAGES CAUSED BY SOIL EROSION OR CONSTRUCTION ACTIVITIES AT OR BEFORE THE END OF EACH WORKING DAY.

4. INSTALL SEDIMENT COLLECTION POND AT END OF THE OUTFALL & AT THE END OF THE DITCHES TO FILTER SEDIMENT FROM SURFACE RUNOFF BEFORE IT IS DISCHARGED TO WATERCOURSE.

5. ENSURE THAT RUNOFF IS DIRECTED THROUGH SEDIMENT COLLECTION

6. DO NOT DISTURB EXISTING VEGETATION ANY MORE THAN NECESSARY TO COMPLETE EACH PHASE OF THE PROJECT.

7. INSTALL A LAYER OF MULCH OR AN EROSION CONTROL BLANKET TO ALL EXPOSED SLOPES THAT IS NOT IMMEDIATELY UNDER CONSTRUCTION APPLIED AND MAINTAINED UNTIL THE AREA IS READY TO BE COMPLETED.

8. SEED/SOD ALL EXPOSED AND BARREN SOIL AS SOON AS POSSIBLE.

9. ALL WORK TO BE PERFORMED IN ACCORDANCE WITH PEI OCCUPATIONAL HEALTH & SAFETY ACT, FEDERAL, PROVINCIAL & MUNICIPAL BY-LAWS & REGULATIONS.

10. ENVIRONMENTAL PROTECTION MEASURES SHALL BE CARRIED OUT TO THE SATISFACTION OF THE CONSULTANT &, AUTHORITIES HAVING JURISDICTION AND THE COST OF ALL THESE DEVICES & MEASURES SHALL BE INCLUDED IN THE CONTRACT PRICE.

11. REPORT ANY DOUBTFUL CONDITIONS REQUIRING DECISIONS & SECURE DIRECTIONS FROM THE CONSULTANT BEFORE PROCEEDING WITH THE WORK.

12. THE CONTRACTOR IS TO HAVE ON HAND, THE APPROPRIATE


EMERGENCY RESPONSE PHONE NUMBERS AND CONTACTS TO ALERT THE APPROPRIATE AUTHORITIES OF POSSIBLE CONTAMINATION SHOULD A

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Drawing Number

Architecture + Engineering + Project Management

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- 1. THE WORK SHALL BE IN ACCORDANCE WITH NATIONAL BUILDING CODE OF CANADA (NBCC), LATEST REVISION, TO THE SATISFACTION OF THE ENGINEER UNLESS NOTED OTHERWISE ON THE DRAWING OR IN THE SPECIFICATIONS.
- 2. COMPLY WITH ALL LOCAL, MUNICIPAL, AND PROVINCIAL BY-LAWS AND REGULATIONS.
- 3. ALL WORK SHALL BE PERFORMED IN ACCORDANCE WITH PEI OCCUPATIONAL HEALTH & SAFETY ACT, WORKPLACE HAZARDOUS MATERIALS INFORMATION SYSTEM AND APPLICABLE LABOR CODES.
- 4. CONTRACTOR MUST VISIT THE SITE AND BE FAMILIAR WITH EXISTING CONDITIONS, VERIFY EXACT LOCATION OF
- ALL EXISTING UTILITIES AND SERVICES WITHIN THE CONTRACT LIMIT. 5. CONTRACTOR SHALL COORDINATE WORK AND COOPERATE WITH OWNER AND AGENCIES HAVING JURISDICTION.
- 6. REPORT ANY DOUBTFUL CONDITIONS REQUIRING DECISIONS AND SECURE DIRECTIONS FROM THE ENGINEER BEFORE PROCEEDING WITH THE WORK.
- 7. VERIFY ALL DIMENSIONS AND REPORT ANY DISCREPANCIES TO THE ENGINEER BEFORE PROCEEDING WITH THE
- 8. ALL DIMENSIONS AND ELEVATIONS ARE IN IMPERIAL UNITS UNLESS NOTED OTHERWISE. 9. THE CONTRACTOR TO INCLUDE IN THE CONTRACT PRICE COSTS ASSOCIATED WITH OVER EXCAVATION,
- 10. PROPERLY DISPOSE AND REMOVE OFFSITE ALL DEBRIS AND MATERIALS TO BE REMOVED.
- 1. FOOTINGS SHALL NOT BE PLACED ON SOIL SOFTENED BY WATER.
- 2. ALL FOOTINGS SHALL BE PLACED ON SOIL HAVING A SAFE BEARING PRESSURE OF 145 kN/SQ.m (3000 psf). REFER TO SOIL INVESTIGATION REPORT #210613, PREPARED BY EASTTECH ENGINEERING CONSULTANTS INC. DATED
- 3. ALL FOOTINGS SHALL HAVE A MINIMUM OF 1500mm (5'-0") FROST PROTECTION.
- 4. ALL FOOTINGS SHALL BE REVIEWED BY THE ENGINEER BEFORE CONCRETE IS PLACED.
- 5. VERIFY ALL CONCRETE FORMWORK LINES ARE LEVEL, PLUMB, SQUARE AND TRUE.
- 6. CONCRETE FORMWORK PLYWOOD SHEETS TO THE REQUIREMENTS OF CSA 0121. USE NEW MATERIAL, CLEAN, SOUND, FREE FROM DEFECTS DETRIMENTAL TO THE QUALITY OF FINISHED CONCRETE SURFACES. ARRANGE PLYWOOD SHEETS TO A UNIFORM JOINT PATTERN. CONSTRUCT FORMWORK TO RESIST FLUID PRESSURE FROM WET CONCRETE AND ALL OTHER CONSTRUCTION LOADINGS WITHOUT BULGING, MOVEMENT OR DISTORTION. REUSE OF FORMWORK SUBJECT TO THE REQUIREMENTS OF CSA A23.1.
- 7. OPENINGS IN FOUNDATION & BUILDING WALLS SHALL BE PROVIDED AS SHOWN ON ARCHITECTURAL, MECHANICAL AND ELECTRICAL DRAWINGS. ANY ADDITIONAL OPENINGS MUST BE APPROVED BY ENGINEER. OPENINGS SHALL BE SLEEVED. CORING SHALL NOT BE ACCEPTABLE.
- 8. ALL WALL AND SLAB OPENINGS AND ENDS SHALL HAVE MINIMUM (2)-15M ALL SIDES.
- 9. LOCATION OF CONSTRUCTION JOINTS TO BE APPROVED BY ENGINEER BEFORE CONCRETE IS PLACED.
- 10. ANCHOR RODS AND EMBEDDED STEEL ITEMS WILL BE INSTALLED BY THE FOUNDATION CONTRACTOR. SET ANCHOR RODS, INSERT PLATES, SLEEVES AND OTHER MISCELLANEOUS ITEMS EMBEDDED IN CONCRETE ACCURATELY, USING TEMPLATES, TO EXACT GRADE AND LOCATION SHOWN ON PROJECT DRAWINGS OR AS DIRECTED BY ENGINEER. SECURE TO PREVENT DISPLACEMENT DURING CONCRETE PLACEMENT. DO NOT CUT OR RELOCATE REINFORCING STEEL FOR PLACEMENT OF EMBEDDED PARTS. IF INSERTS CANNOT BE LOCATED AS SPECIFIED, OBTAIN APPROVAL OF ALL MODIFICATIONS FROM ENGINEER BEFORE PLACING.
- 11. ALL BASE AND BEARING PLATES TO BE GROUTED USING 50 MPa (7200psi) NON-SHRINK GROUT. CURE NON-SHRINK GROUT AND PROTECT FROM FREEZING TEMPERATURES IN ACCORDANCE WITH CSA UNLESS NOTED OTHERWISE.
- 12. THE FILL SHALL BE PLACED SIMULTANEOUSLY ON BOTH SIDES OF THE FOUNDATION WALL. PROVIDE LATERAL SUPPORT TO WALLS PRIOR TO BACKFILLING.

—HURRICANE ANCHORS, EACH END, EACH TRUSS

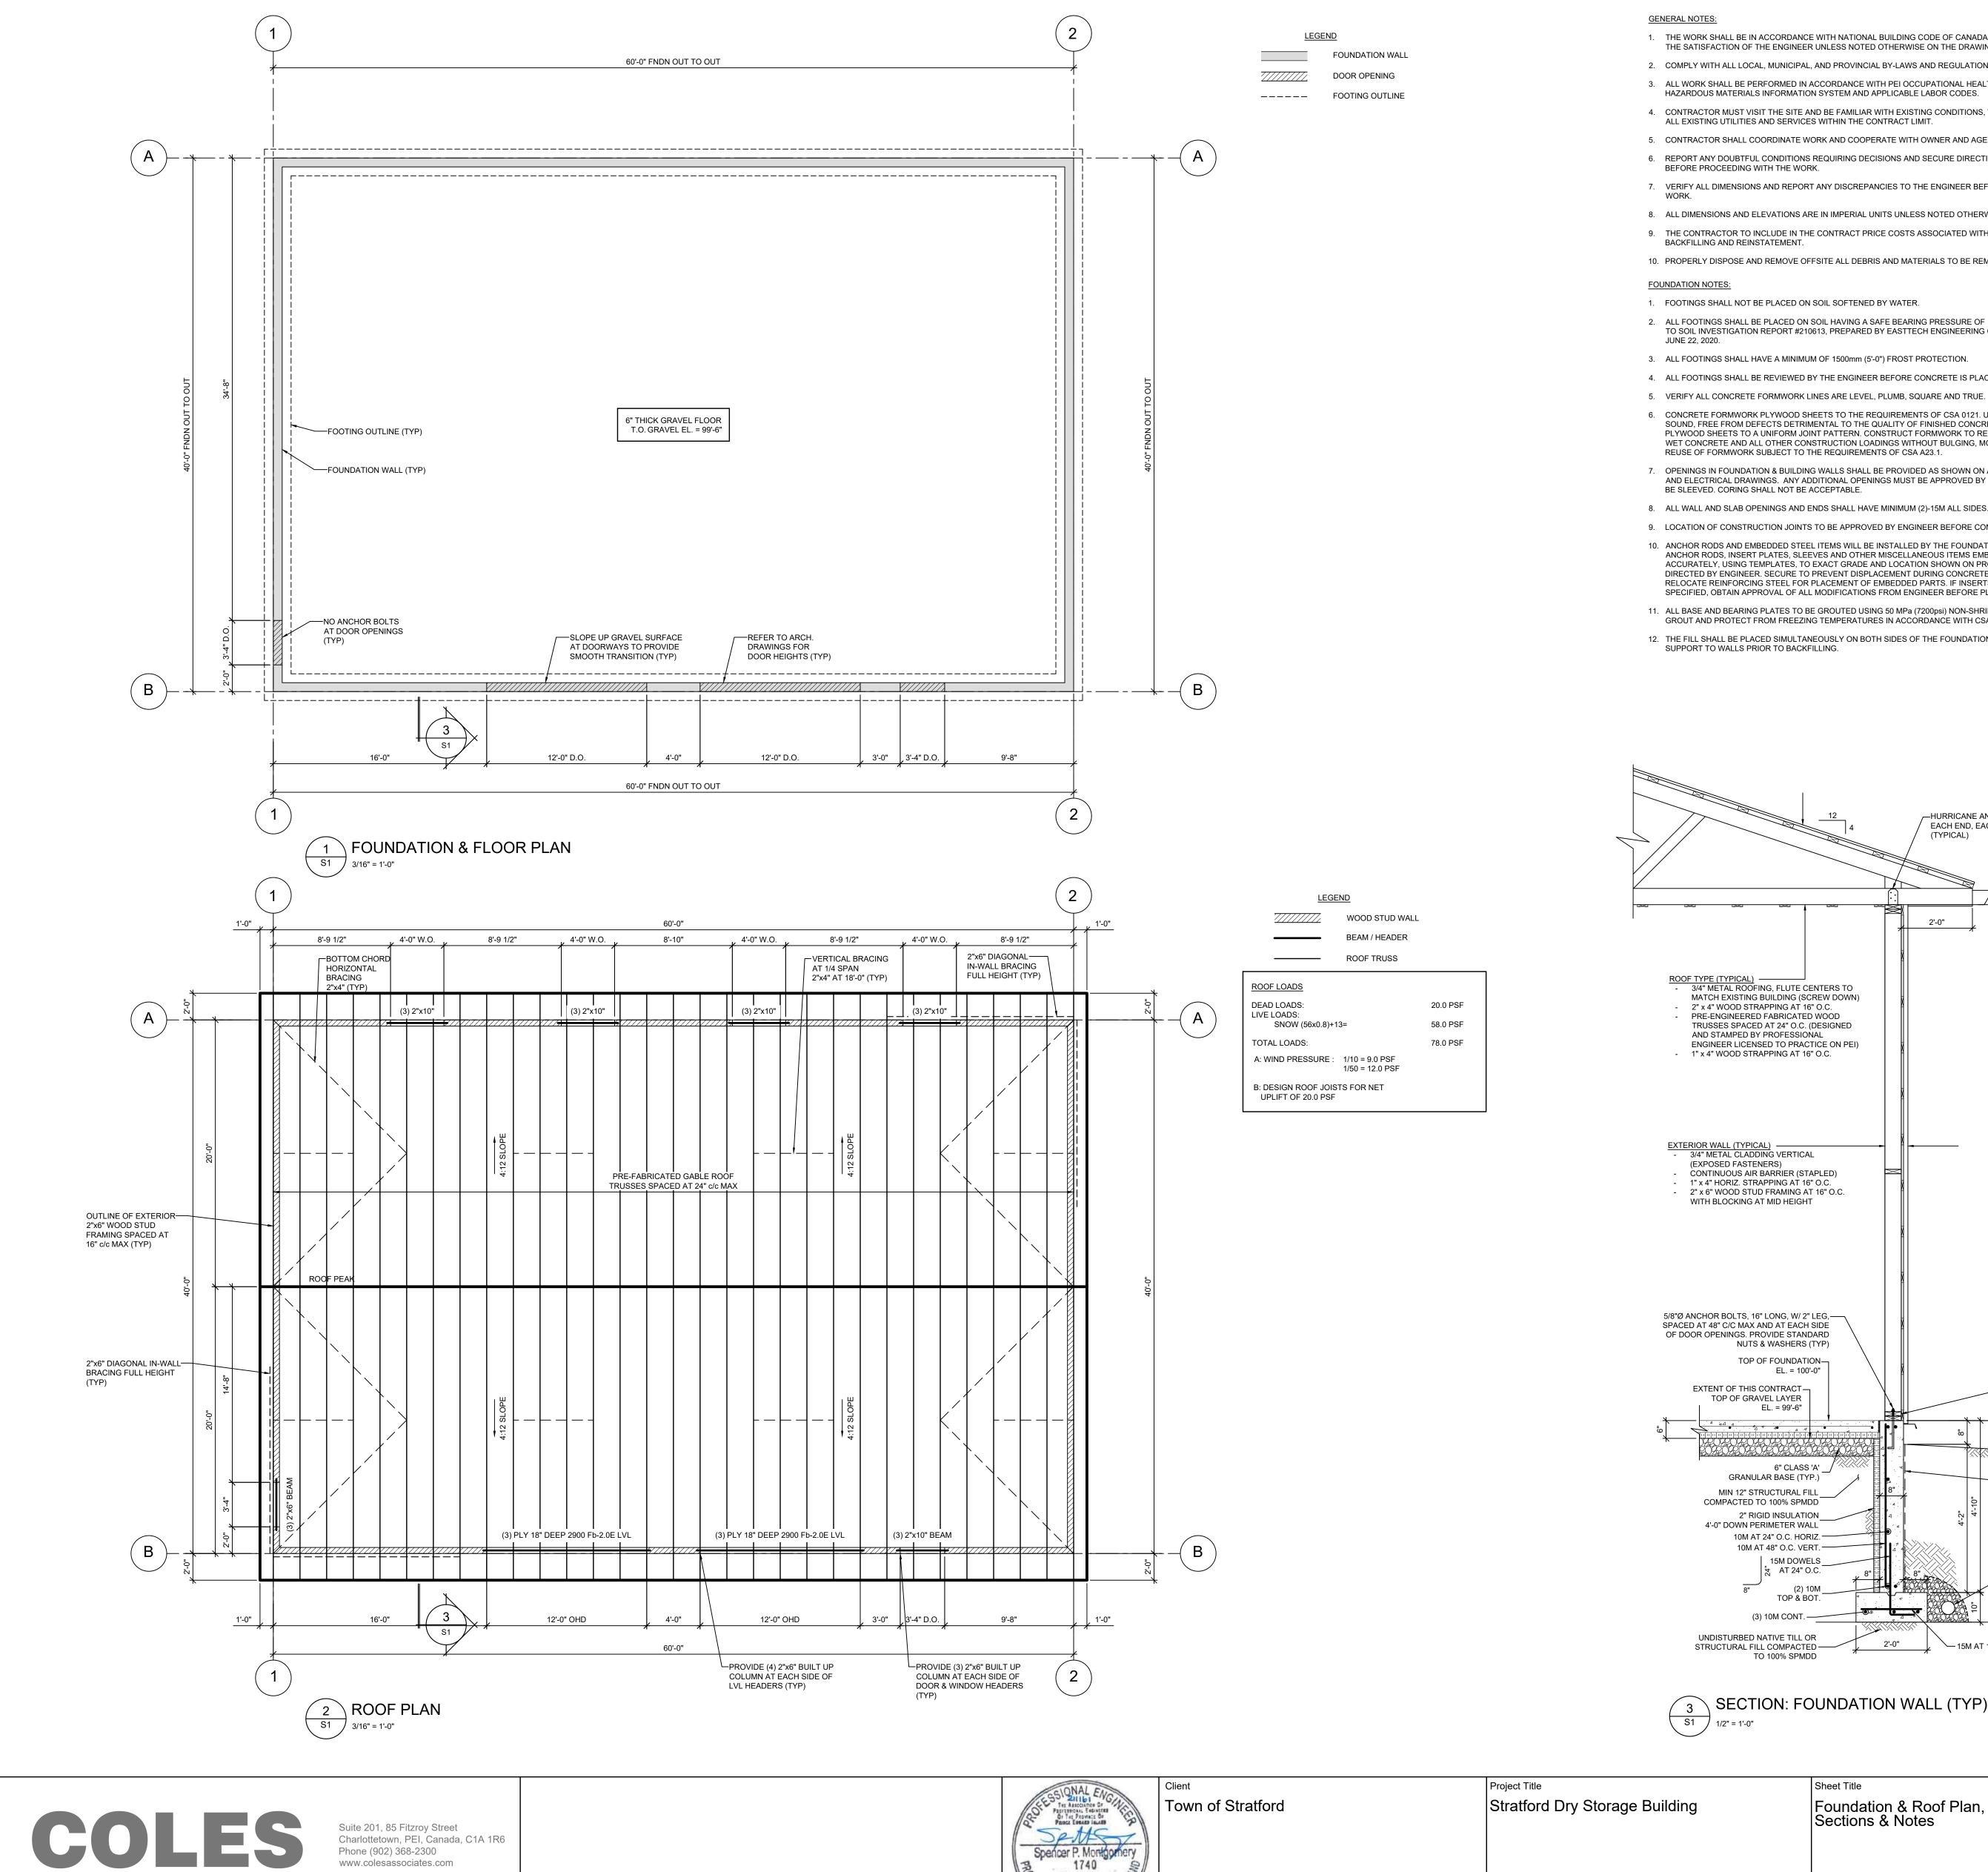(TYPICAL)

CONCRETE NOTES:

- 1. ALL CONCRETE WORK SHALL BE CARRIED OUT IN ACCORDANCE WITH LATEST CSA A23.1 AND NBCC.

 - b. AGGREGATES: CSA A23.1
 - c. AIR ENTRAINMENT: CSA CAN3-A266.1 d. CHEMICAL ADMIXTURES: CSA CAN3-266.2
 - e. DESIGN MIX: CSA A23.1
 - 3. MIX DESIGN: TYPE 10 PORTLAND CEMENT.
 - COMPRESSIVE STRENGTH (28D): 25MPa (3600psi)
 - b. CLASS OF EXPOSURE: F-2 c. NOMINAL AGGREGATE SIZE: 20mm (3/4")
 - d. SLUMP: 80mm (3-1/4") ±20mm (3/4") e. AIR CONTENT: 4-7%

6. USE OF CALCIUM CHLORIDE IS NOT PERMITTED.

- f. WATER CEMENT RATIO: 0.5 MAX 5. CONCRETE MIX DESIGN SHALL BE SUBMITTED FOR REVIEW BY THE ENGINEER MINIMUM 48 HRS PRIOR TO CASTING.
- 7. NO CONCRETE SHALL BE POURED WITHOUT THE PRIOR KNOWLEDGE AND APPROVAL OF ENGINEER.
- 8. ALL CONCRETE SHALL BE TESTED, TESTING SHALL CONFORM TO CSA A23.2. RECORD TESTS FOR SLUMP, AIR
- 9. ALL CONCRETE SHALL BE VIBRATED USING HIGH FREQUENCY VIBRATORS. VIBRATION PRACTICES TO BE IN ACCORDANCE WITH ACI 309R.
- 10. COLD WEATHER CONCRETE SHALL BE PLACED AND PROTECTED IN ACCORDANCE WITH THE REQUIREMENTS OF CSA A23.1 AND TO THE REQUIREMENTS OF ACI-306R. PROVIDE HEATED ENCLOSURES AND/OR INSULATED TARPS AS REQUIRED TO MAINTAIN MINIMUM 10°C CONCRETE SURFACE TEMPERATURE FOR A PERIOD OF 5 DAYS FOLLOWING CONCRETE PLACEMENT. PROVIDE CONTROLLED COOL DOWN PERIOD TO PREVENT SURFACE CRACKING AT END OF PROTECTION PERIOD. ENSURE THAT NO CONCRETE IS PLACED ON OR AGAINST FROZEN
- SUBGRADE, FORMWORK, OR REINFORCING STEEL. 11.LEAVE FORMWORK IN PLACE FOR THE FOLLOWING MINIMUM PERIODS OF TIME AFTER PLACING CONCRETE: a. 72 HR. FOR WALLS
- b. 72 HR. FOR FOOTINGS 12. APPLY CURING COMPOUND TO WALLS AND PILASTERS IF EXPOSED TO DRYING CONDITIONS PRIOR TO COMPLETION

OF FULL 7 DAY MOIST CURING PERIOD. USE LIQUID MEMBRANE CONCRETE CURING COMPOUND.

REINFORCING STEEL NOTES:


- 1. ALL REINFORCING STEEL SHALL BE NEW BILLET AND SHALL CONFORM TO CSA G30.18, WWM REINFORCING TO CSA
- 2. MINIMUM REINFORCING STEEL YIELD STRENGTH SHALL BE 400 MPa.
- 3. REINFORCING STEEL SHALL BE DETAILED, CUT, BENT, FABRICATED AND PLACED IN ACCORDANCE WITH REINFORCING MANUAL OF STANDARD PRACTICE (REINFORCING STEEL INSTITUTE OF CANADA); CAN3-A23.3 AND
- 4. THE GENERAL CONTRACTOR SHALL INSPECT ALL THE REINFORCING STEEL BEFORE PLACEMENT OF THE
- 5. THE GENERAL CONTRACTOR SHALL NOTIFY THE ENGINEER 24 HOURS PRIOR TO THE PLACEMENT OF THE
- CONCRETE.
- 6. THE POSITION OF ALL REINFORCING STEEL SHALL BE MAINTAINED DURING THE POURING OPERATION BY DIRECT SUPERVISION OF THE REINFORCING STEEL CONTRACTOR. SHOP DRAWINGS: SUBMIT SHOP DRAWINGS STAMPED BY AN ENGINEER LICENSED TO PRACTICE IN PEI FOR

REVIEW PRIOR TO FABRICATING REINFORCING STEEL. CLEARLY INDICATE BAR SIZES, SPACING, LOCATION,

8. ALL FOOTING REINFORCING SHALL CONTINUE THROUGH COLUMN FOOTINGS AND SHALL CONTINUE TO THE ENDS OF THE FOOTINGS WHERE FOOTINGS CHANGE DIRECTION OR STOP.

QUANTITY, CHAIRS, SPACERS, ETC WITH IDENTIFYING CODE MARKS TO PERMIT PLACEMENT.

- 9. ALL WALL REINFORCING SHALL CONTINUE THROUGH PIER/COLUMN REINFORCING.
- a. POURED AGAINST THE GROUND b. FORMED SURFACE AGAINST GROUND
- c. FORMED SURFACE EXPOSED TO WEATHER 50mm (2") d. FORMED SURFACE PROTECTED:
- 11. USE SPACERS, CHAIRS, TEMPLATES AND DIRECT SUPERVISION OF THE REINFORCING STEEL CONTRACTOR TO ACCURATELY LOCATE & SUPPORT REINFORCING STEEL & SECURE IN POSITION TO PREVENT DISPLACEMENT DURING CONCRETE PLACEMENT.

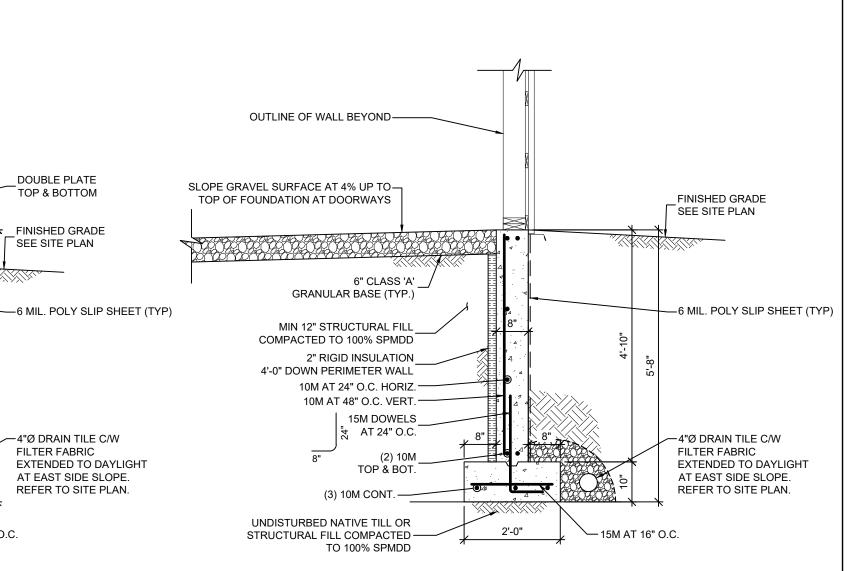

4 SECTION: FOUNDATION WALL AT DOORWAY (TYP) S1 / 1/2" = 1'-0"

NUTS & WASHERS (TYP) TOP OF FOUNDATION-

EL. = 99'-6

GRANULAR BASE (TYP.)

2" RIGID INSULATION

10M AT 24" O.C. HORIZ.-

(3) 10M CONT. -

TO 100% SPMDD

10M AT 48" O.C. VERT. -

AT 24" O.C.

TOP & BOT.

MIN 12" STRUCTURAL FILL

6" CLASS 'A'

Foundation & Roof Plan, Sections & Notes

Sheet Title

Description Date: November 2021 2021-11-18 Drn By: SPM, P.Eng Issued for Tender 2021-11-30 Chk By: SPM, P.Eng / NL, P.Eng Issued for Addendum #1 Project Number: 211161 Drawing Number:

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— 15M AT 16" O.C.

DOUBLE PLATE

TOP & BOTTOM

FINISHED GRADE SEE SITE PLAN

-4"Ø DRAIN TILE C/W

REFER TO SITE PLAN.

FILTER FABRIC

